GENERAL NOTES

These drawings are to be read in conjunction with accompanying Project and

General Specifications. Engineers, Soil Report etc where applicable. All dimensions and levels are to be checked and verified by the Owner/Builder, and any discrepencies in the documents must be resolved before ordering or commencement of any works.

These drawings are not to be scaled. Use written dimensions only.

CODES AND REGULATIONS

All work and materials shall conform to current Australian Standards, and to the Building Code of Australia. The builder shall confirm in all respects to local council requirements, the B.C.A and relevant S.A.A. STRUCTURAL STEEL

All structural steel shall be mild steel to AS3678 and designed in accordance with AS4100 unless otherwise noted on drawings. Structural Steel hollow sections shall be cold formed steel, manufactured to AS1163 having yield strength of 350 Mpa and designed in accordance with AS1538.

All exposed steelwork to be hot dipped galvanised to S.A.A.

TIMBER

Timber used in construction is to conform with the applicable current Australian standards.

Design of timber structures is in accordance with AS 1720.

Timber structures not located in an area subject to seismic activity or snow loads and where the design wind velocity calculated under AS 1170.2 does not exceed 42m/s shall be constructed in accordance AS1684.2. All timber framing to comply with AS1684.

BRICKWORK

Clay bricks shall be used in accordance with AS 3700 and shall a minimum compressive strength of 30 Mpa. Mortars shall be mixed in proportions of 1 part portland cement, 1 part hydrated lime or lime putty and 6 parts fine aggregate volume batched. To all brick walls provide 3mm stainless steel ties placed not further apart then 460mm x 610mm centres sloping downwards to the outside.

Provide Articulation or Expansion Joints at 6.0m ctrs max, and not exceeding 3.0m from any corner, and as per soil report recommendations.

GLAZING

All glazing shall be carried out in accordance with AS 1288. All glass sliding doors shall be clearly marked with safety markings. All framed glazing where the lowest sight line of the glazing panel is less than 500mm from the highest abutting finished floor level shall be Grade A safety glazing material in accordance with AS 1288 except that ordinary annealed glass may be used as follows:

Maximum glazing panel area

Up to and including 0.1 sq.m

Up to and including 0.3 sq.m

Up to and including 2.0 sq.m

All glazing to be standard nominal thick clear annealed unless shown otherwise on elevations.

Provide light and ventilation to the requirements of the B.C.A.

All steps are to have a minimum tread width of 250mm and a maximum riser height of 190mm.

Selected balustrade to stairs or steps where required, 1000mm above landing min. 900mm above steps. WET AREAS

To all wet areas provide ceramic tiles bonded to fully compressed fibre cement sheets or approved similar, to walls to a height not less than 1800mm around shower recesses measured from the lowest point of the shower base, and not less than 300mm above the rim of the bath, vanity, sinks and troughs.

Waterproofing of wet areas to comply with AS3740.

INSULATION

Unless noted otherwise, the following insulation is to be provided for the following types of floor:

Tiled Roof: Refer to energy rating report.

Ext.Walls: Refer to energy rating report.

Any sarking type material must have a flammability index of not more than 5.

Provide cavity flashing from internal frame to external brickwork with bottom course weep holes @1000mm ctrs *For slab on ground*

Provide 75 x 110 G.I. Grilled vents @ 1.5m ctrs to sub-floor external wall. *For timber/concrete floor on strip footings.*

SMOKE ALARMS

Smoke alarm detectors, hard wired to switch board to conform with AS 3786.


THERMAL PERFORMANCE


Proposed dwelling must be constructed to minimise air leakages via roof, external walls, floos and openings such as windows, doors and the like.

Drafts must be restricted via exhaust fans, chimneys, flues, openable windows and other such openings must be fitted with a seal where practical to restrict air infiltration. (Seals must be constructed from a foam or rubber compressible strip, fibrous seal or the like).

When servicing a conditioned space, all roof lights must be sealed or have the capability of being sealed. All windows are assumed to meet AS2047 (Clause 2.1.3.5) and AS4420.4 on air infiltration. Check before orderina.



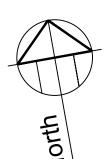

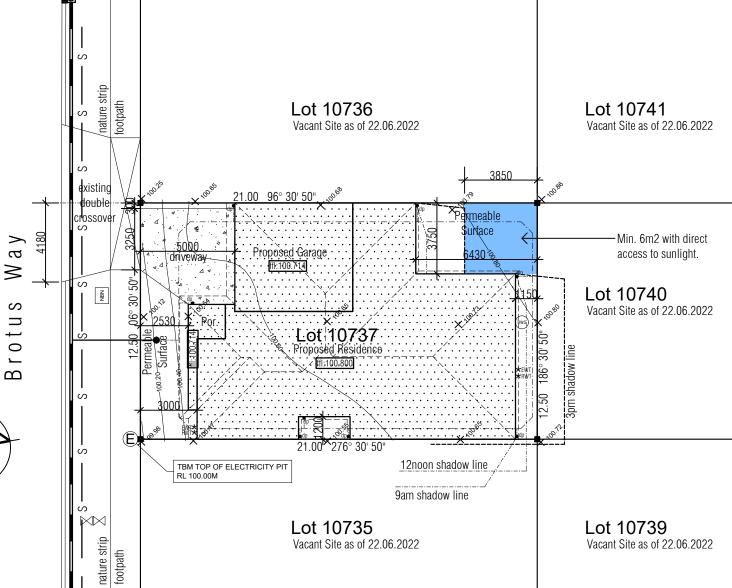

BUSHFIRE REQUIREMENTS

the site is not in a designated bushfire prone area and therefore is not subject to hushfire construction requirements

PLEASE NOTE:

A minimum 2m high steel fence is to be provided to the full extent of the title boundaries throughout the duration of construction works.

Access to the construction area is to be restricted throughout the duration of works.

SITE AREAS: SUBJECT SITE: 263 SQ.M

COVERED AREA: 179.42 SQ.M SITE COVERAGE: 68.22% SITE PERMEABILITY: 60.53 SQ.M

PLEASE NOTE:

Proposed dwelling must incorporate dual plumbing for the use of recycled water in toilet flushing and garden watering.

STORMWATER DRAINAGE REQUIREMENTS

- To be in accordance with BCA Part 3.5.2, AS/NZS 2179.1, AS 1273 for UPVC.
- All underground stormwater drains to be minimum 100mm. Class 6 UPVC at 1 in 100 minimum grade and be provided with the following coverage
 - 100mm under soil 50mm under paved or concrete areas 100mm under concrete areas subject to light traffic.
- All gutters are to be Type B or E with a minimum grade of 1 in 100 to downpipes.
- All downpipes to be a minimum 90mm diametre, metal or UPVC and connect to the underground stormwater drainage system

I/We

acknowledge that these plans are a true and accurate reflection of our requirements and agree that these drawings, are the drawings referred to in our Building Contract, between Everest Homes and myself/ourselves. I/We are fully aware that a Variation fee will occur if any further changes are made on these plans.

SOIL CLASSIFICATION: Refer to Soil Test by others.

All levels to be verified on site prior to commencment of any building

(Signed).

(Signed)..

Date:

Job.No: 3069

Date: Amendment: Date: Issue: Amendment: Issue ISSUE FOR DEVELOPERS APPROVA ISSUE FOR CONSTRUCTION AMENDED THIS DOCUMENT IS THE SUBJECT OF BUILDING PERMIT NUMBER: CBS-U 66127/49434

Lot 10737 Brotus Way, Donnybrook

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building design & drafting service interior design DOREEN PADULA DP-AD 45173

waters edge BUSINESS CENTRE PO Box 3379 Caroline Springs 3023 P: 9217 6405 F: 9217 6444

Date: August 2022

Drawing Title:

Scale: 1:200

site plan

NOTE: Refer to Energy Rating Report for Insulation

All WC doors with clearance <1200 from pan to be readily removable, sliding or hinged outwards.

CJ : Denotes Control Joint to full height of brickwork. All joints to conform to note CN9 of the brickwork and concrete association. Information contained in the soil report regarding

control joints takes precedence. Control joint width must not be less than 10mm.

NOTE:

Pliable building membrane to comply with AS4200.1 and to be installed to AS4200.2 in accordance with Clause 3.8.7.2 of the NCC 2019.

NOTE: Roof stormwater drainage to comply with AS3500.3.

LEGEND		
	METER BOX	
G	GAS METER	
EWT 🛪	EXTERNAL WATER TAP LOCATION	
RWT ★	RECYCLED WATER LOCATION	
[<u>m</u> h]	700mm X 560mm WIDE MANHOLE	
LOH	LIFT OFF HINGE DOOR	
●dp	DOWNPIPE	
	200mm HIGH BULKHEAD, UNLESS NOTED OTHERWISE (Nominal)	
niche	450mmH x 450mmW NICHE AT 1100mm AFL, TO SHOWERS (UNLESS NOTED OTHERWISE).	
	RAKED CEILING	
skylight SKYLIGHT - 450mm DIAMETRE		
■rwh	RAIN WATER HEAD	
Mbn	NBN/PCD EXTERNAL CONNECTION POINT, MAX. 700mm IN HEIGHT.	

Smoke Detectors to comply with AS3786 and interconnected to mains in accordance with BCA-Part 3.7.5.

Exhaust Fan. Exhaust fan flow rates as per the clause 3.8.7.3 of NCC 2019. Bathroom or Sanitary compartment -25L/s. Kitchen or Laundry -40L/s.

Exhaust fans to be ducted to outside air.

179.42 sq.m (19.31 sqrs).

Residence: 138.28 sq.m (14.88 sqrs). 5.33 sq.m (0.57 sqrs). Garage: 35.81 sq.m (3.85 sqrs).

WET AREA DETAILS


TOTAL:

All building elements in wet areas within a building must comply with AS3740. Floors: All bathroom and laundry floors are to be cement sheet with waterproof membrane and tiles over. Provide waterstop to the extremity of wet area floor where openings occur in walls. Shower floors are to utilize preformed bases. Walls: Shower walls are to be cement sheet with waterproof membrane and tiles over to a

height of 1.8m. Where basin, baths and the like are located, provide a waterproof membrane with tiles to a height of not less than 150mm above the vessel.

Kitchen splashbacks: Waterproof membrane is to be provided to walls where kitchen sink and stove top is located, a 4mm toughened grade A safety glass splashback is to be installed over

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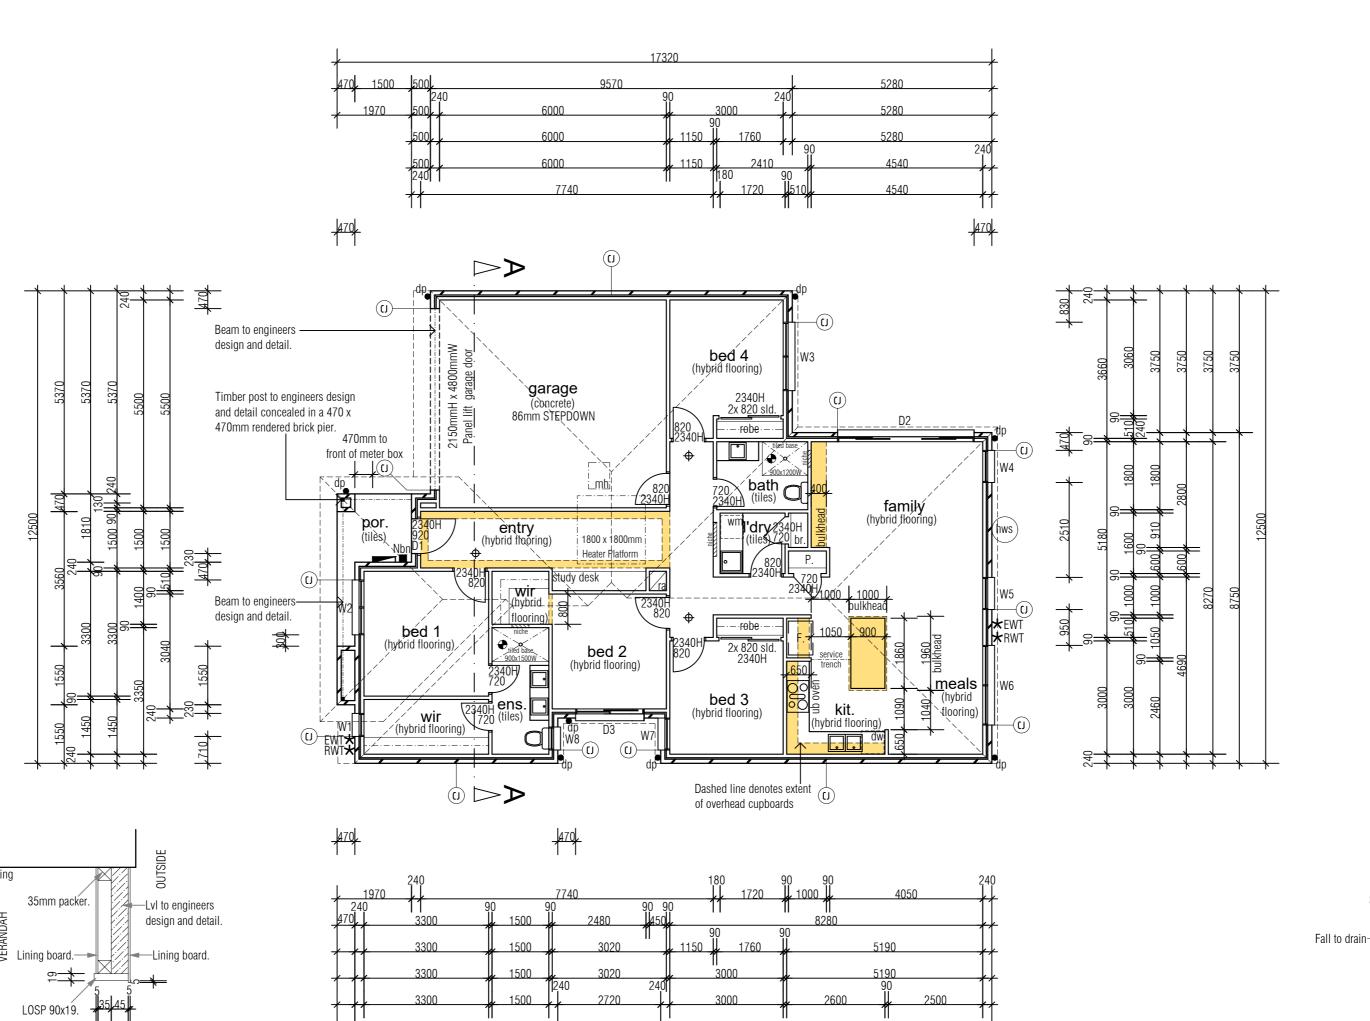
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waters edge BUSINESS CENTRE PO Box 3379 Caroline Springs 3023

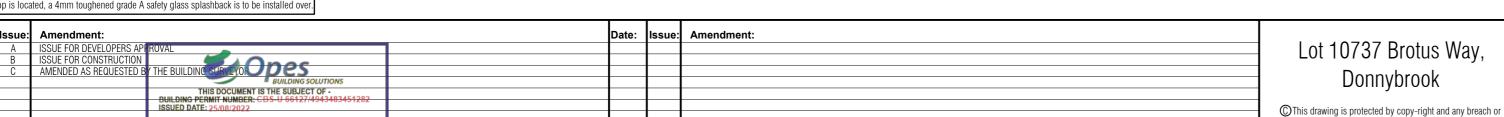P: 9217 6405 F: 9217 6444

Date: August 2022 **Job.No:** 3069 Scale: 1:100 Drawing Title:

floor plan



step down Waterproof membrane to be applied. Water stopper

-Shower Screen

-12mm as selected tiles

Screed-

Unless dimensioned door(s) and window(s) are to be

Provide Aluminium framed flyscreens and keyed locks

centred to rooms and suit brick nominals

Provide 50mm slab recess to shower bases.

(+ or -50 mm).


to all openable windows.

typical recessed shower detail scale 1:20

acknowledge that these plans are a true and accurate reflection of our requirements and agree that these drawings, are the drawings referred to in our Building Contract, between Everest Homes and myself/ourselves. I/We are fully aware that a Variation fee will occur if any further changes are made on these plans. (Signed)... (Signed). ..Date:.

THIS DOCUMENT IS THE SUBJECT OF BUILDING PERMIT NUMBER: CBS-U 66127/49434(
ISSUED DATE: 25/08/2022

LVL lining detail Scale 1:10

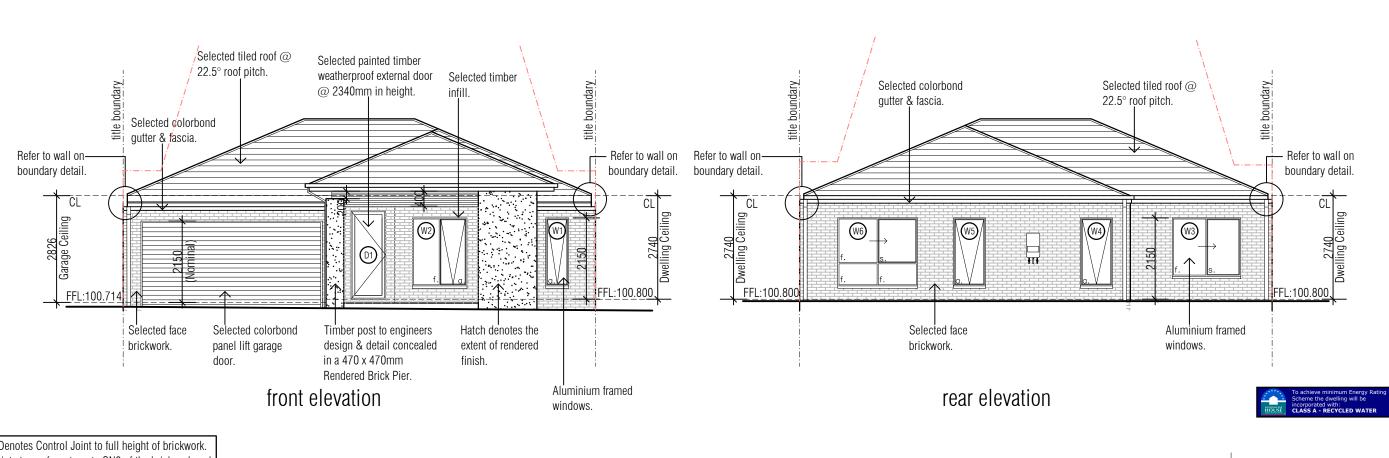

CJ: Denotes Control Joint to full height of brickwork. All joints to conform to note CN9 of the brickwork and concrete association.

Information contained in the soil report regarding control joints takes precedence.

Control joints not to have a width less than 10mm.

NOTE: Roof stormwater drainage to comply with AS3500.3.


LEGEND	
CL	CEILING LINE
FL	FLOOR LINE
S	SLIDING WINDOWS
А	AWNING WINDOWS
F	FIXED GLASS WINDOWS
	OBSCURRED GLAZING

NOTE:

Pliable building membrane to comply with AS4200.1 and to be installed to AS4200.2 in accordance with Clause 3.8.7.2 of the NCC 2019.

THRESHOLDS

Thresholds to Porch will not exceed 230mm for doors leading to external areas (Porch, Verandah & Laundry Door).

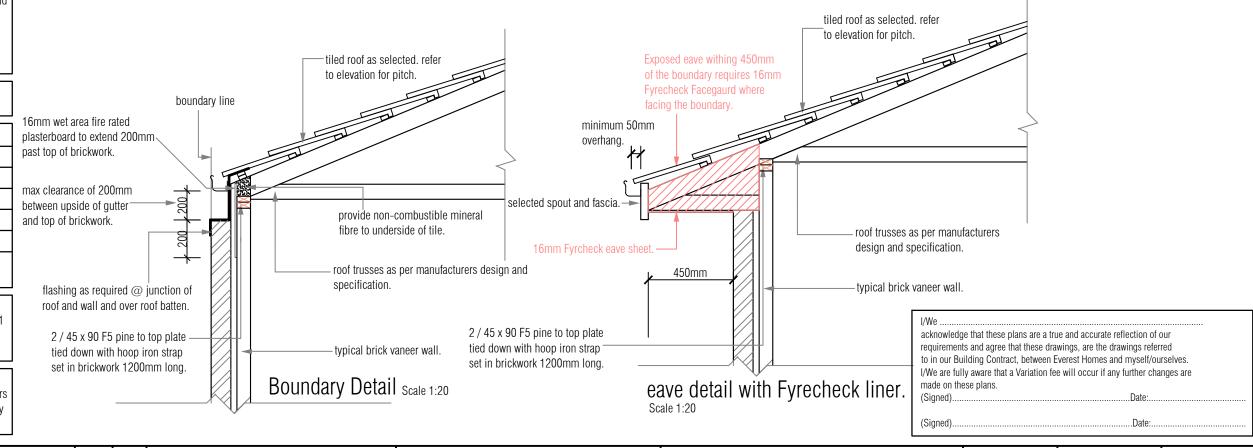

Date:	Issue:	Amendment:	Date:	Issue:	Amendment:	
June 22	Α	ISSUE FOR DEVELOPERS APPROVAL				
Aug 22	В	ISSUE FOR CONSTRUCTION				
Aug 22	С	AMENDED AS REQUESTED BY THE BUILDING SURVEYOR				
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		BUILDING PERMIT NUMBER: CBS-U 66127/494348:	9451282			

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Scale: 1:100


elevations

CJ: Denotes Control Joint to full height of brickwork. All joints to conform to note CN9 of the brickwork and concrete association.

Information contained in the soil report regarding control joints takes precedence.

Control joint width must not be less than 10mm.

NOTE: Roof stormwater drainage to comply with AS3500.3.

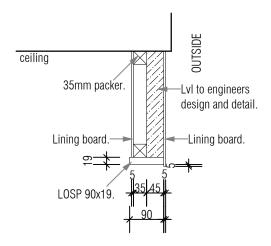

LVL lining detail Scale 1:10



Pliable building membrane to comply with AS4200.1 and to be installed to AS4200.2 in accordance with Clause 3.8.7.2 of the NCC 2019.

THRESHOLDS

Issue:


Date:

Thresholds to Porch will not exceed 230mm for doors leading to external areas (Porch, Verandah & Laundry Door).

ISSUE FOR DEVELOPERS APPROVAL ISSUE FOR CONSTRUCTION


Amendment:

AMENDED

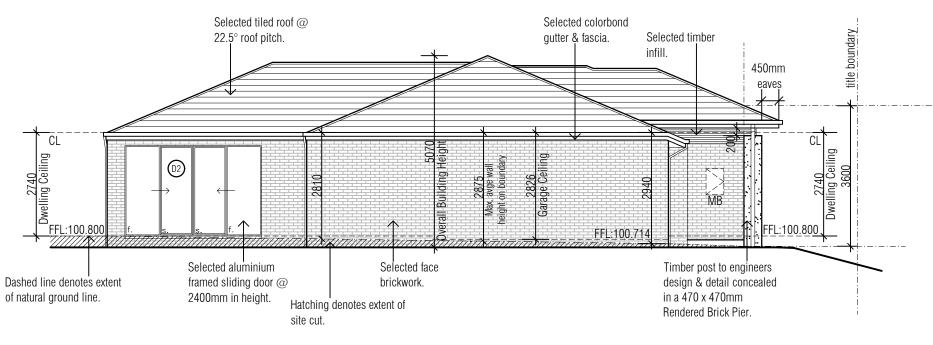

side 1 elevation



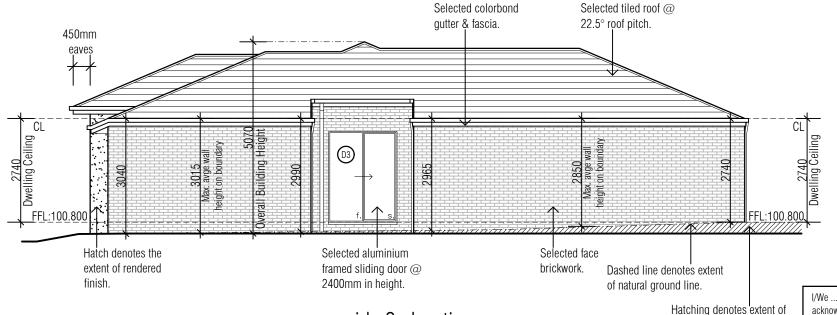

side 2 elevation

acknowledge that these plans are a true and accurate reflection of our requirements and agree that these drawings, are the drawings referred to in our Building Contract, between Everest Homes and myself/ourselves. I/We are fully aware that a Variation fee will occur if any further changes are made on these plans.

(Signed).

PO Box 3379, Caroline Springs 3023

waters edge BUSINESS CENTRE

P: 9217 6405 F: 9217 6444

(Signed)..

Date: August 2022

Job.No: 3069

Drawing Title:

Scale: 1:100

elevations

Amendment: Issue

Lot 10737 Brotus Way, Donnybrook

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interior design DOREEN PADULA DP-AD 45173

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site cut.

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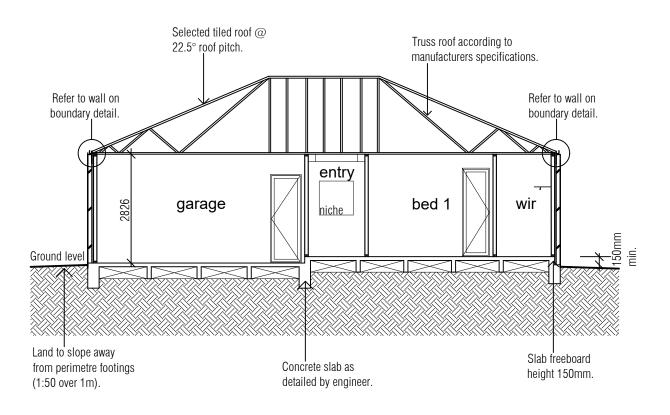
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THIS DOCUMENT IS THE SUBJECT OF BUILDING PERMIT NUMBER: CBS-U 66127/49434

Date:

	WINDOW / DOOR SCHEDULE									
	AL	L WINDOW(S) / DOOR(S) SIZE	S ARE FROM DOWELL	WINDOWS						
No.	LOCATION	WINDOW / DOOR SIZE (H x W)	OPENING TYPE	GLAZING TYPE						
W1	WIR	1800mm x 610mm	Awning	SG 3mm Grade A Safety Glass						
W2	Bed 1	1800mm x 1450mm	Awning	SG 3mm Grade A Safety Glass						
W3	Bed 4	1543mm x 1810mm	Sliding	SG 3mm						
W4	Family	1800mm x 850mm	Awning	SG 3mm Grade A Safety Glass						
W5	Family	1800mm x 850mm	Awning	SG 3mm Grade A Safety Glass						
W6	Meals	1800mm x 2110mm	Sliding	SG 3mm						
W7	Bed 3	1800mm x 850mm	Awning	SG 3mm Grade A Safety Glass						
W8	Ensuite	1027mm x 610mm	Awning	SG 3mm Grade A Safety Glass / Obscured						
D1	Entry	2340mm x 920mm	Solid Door	-						
D2	Family	2400mm x 3610mm	Sliding Door	SG 5mm Grade A Safety Glass						
D3	Bed 2	2400mm x 1810mm	Sliding Door	SG 5mm Grade A Safety Glass						



Soil Classification: Refer to Soil Report test by others.

NOTE:

Sarking to be provided as per the requirements outlined in table 3.5.2.2. of the NCC 2019.

section a:a



3.5.2.4 Sarking

All timber framing must be in accordance with AS 1684.

The below is to be read in conjunction with any engineering plans and documents. Engineering requirements to take precedent.

- Bottom plates to be min 45x90 MGP10.
- Top plates to be min 2/45x90 MGP10.
- Common studs to be 90x45 MGP10.

TIMBER FRAMING REQUIREMENTS

Direct support for Girder Trusses to be 2/90x45 MGP10 stud nail laminated and fastened with 4/90x3.05mm nails through bottom plates. Where required provide blocks to floor space and continue double studs through lower level framing.

GENERAL ENERGY EFFICIENCY REQUIREMENTS

- Construction must be in accordance with the Energy Rating Report.
- Wall Insulation (Refer to Energy Rating Report).
- Ceiling Insulation (Refer to Energy Rating Report).
- Chimneys or flues of solid fuel burning appliances must be provided with a damper or flap that can be closed/sealed when not in use.
- Roof lights in a conditioned space are to be provided with an imperforate ceiling diffuser a weatherproof seal or a shutter system.
- Windows and doors in a conditioned space or habitable room must comply with AS2047, be sealed against air infiltration or be provided with weather strips and draft protectors.
- Exhaust fans to be provided with self sealing dampers and ducted to outside.
- Roofs, external walls, external floors must be constructed to minimise air leakag, all lining junctions to be close fitting and be sealed by caulking/skirting, architraves, cornices or the like
- Evaporative coolers must be fitted with a self closing damper.

Sarking must—

(a) be provided in accordance with Table 3.5.2.2; and

(b) comply with AS/NZS 4200.1 and be installed with-

(i) each adjoining sheet or roll being-

(A) overlapped not less than 150 mm; or

(B) taped together; and

(ii) sarking fixed to supporting members at not more than 300 mm centres; and

Sarking-type materials used in the roof must have a flammability index not greater than 5.

(iii) no sags greater than 40 mm in the sarking.

Table 3.5.2.2 Sarking requirements for tiled roofs

Roof pitch	Maximum rafter/truss top chord length without sark- ing (mm) Note 1
<18°	N/A Note 2
>18° <20°	4 500
>20° <22°	5 500
>22°	6 000

Notes to Table 3.5.2.2:

- 1. The maximum rafter/truss top chord length is measured from the topmost point of the rafter/truss i.e. the apex downwards. Where the maximum length is exceeded, sarking must be installed over the remainder of the rafter/truss top chord length towards the eave line of the roof, or equivalent where the building has no eaves.
- 2. All tiled roofs with a pitch less than 18 degrees must be provided with sarking, regardless of rafter/truss chord

GENERAL NOTES

All windows adjacent to baths within 1.5m and all sliding doors to be safety glass to AS.1288. Floor to ceiling heights may alter due to floor covering materials chosen by owner, builder or contractor.

All wc doors to have lift off hinges.

If the threshold sill of a door is greater than 190mm above the finished surface of the ground to which the doorway opens, a landing shall be provided no less than the width of the doorway.

GLAZING SCHEDULE

Glass to windows and doors shall be fitted in accordance with the following table and as required by the Australian Standards 1288 - 1994.

			Wir	ndows	3		
Maximum Glass Area (m). Glass Thickness (mm).	0.9 3		2.0				
			Doo	ors			
Maximum Glass Area (m).	0.4	0.5	Doo 0.7		2.0	3.0	

TIMBER FRAMING SCHEDULE

The sizes of timber members and types shall be in accordance with the approved working drawings, the B.C.A and A.S. 1684 - Light Timber Framing Manual. It shall generally conform of the following:

Top Plates 2/90 x 45 MGP10 **Bottom Plates** 90 x 45 MGP10

Studs up to 2.7 90 x 35 MGP10 @ 450 ctrs Studs up to 3.0 90 x 45 MGP10 @ 450 ctrs

Jamb Studs 90 x 45 MGP10

INSULATION REQUIREMENTS

- All insulation to abut or overlap adjoining insulation or supporting members.
- Must form a continuous barrier with floors, ceilings, walls or the like that inherently contribute to the thermal barrier
- Must not affect or effect operation of a domestic service or fitting.
- Reflective insulation must be installed with the necessary airspace between reflective side and building lining.
- Reflective insulation to be closely fitted to penetration and openings and adequately supported by framing members.
- Reflective insulation to be overlapped by 150mm or taped together.
- Bulk insulation to maintain in position and thickness other than at roof battens, pipes
- In a ceiling, where there is no bulk insulation or reflective insulation in the external wall beneath, the *reflective insulation* must overlap by no less than 50mm.

I/We	
	e a true and accurate reflection of our
requirements and agree that thes	se drawings, are the drawings referred
to in our Building Contract, betw	veen Everest Homes and myself/ourselves.
I/We are fully aware that a Variati made on these plans.	ion fee will occur if any further changes are
(Signed)	Date:
(Signed)	Date:

Date:	Issue:	Amendment:	Date:	Issue:	Amendment:
Aug 22	Α	ISSUE FOR CONSTRUCTION			
Aug 22	В	AMENDED AS REQUESTED BY THE BUILDING SURVEYOR			
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		BUILDING SOLUTION	S		

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building design & drafting service interior design DOREEN PADULA DP-AD 45173

waters edge BUSINESS CENTRE PO Box 3379 Caroline Springs 3023 P: 9217 6405 F: 9217 6444 Scale: 1:100 Date: August 2022 Job.No: 3069

Drawing Title:

section a:a

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NOTE: additional to the lighting plan an allowance needs to be made for:

- a batten light in ceiling space with switch near manhole

(P) PENDANT LIGHT POINT

(A) BUILDERS RANGE ALARM

(with 'S' has sensor)

(B) BATTEN HOLDER

⊕ EXTERNAL LIGHT

WALL LIGHT

DECKING LIGHTS

tel TELEPHONE POINT

tv TELEVISION POINT

CEILING FAN

REFRIDGERATED COOLING & DUCTED HEATING

DUCTED HEATER RETURN

AIR (CEILING MOUNTED)

■ EVAPORATIVE COOLING

★ DOUBLE POWER POINT

DUCT


IXL 3 in 1

── FLUORESCENT LIGHT

- a single power point to oven

- a single power point to rangehood

DOWNLIGHT

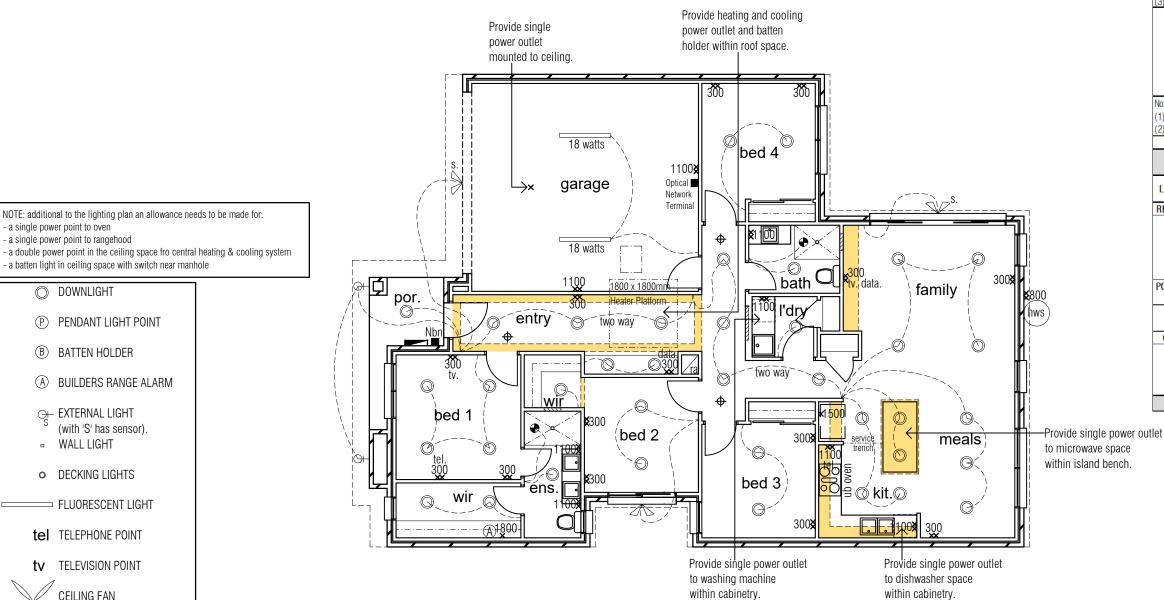

ARTIFICIAL LIGHTING CALCULATIONS

Artificial lighting to comply with NCC 2019

The lamp power density or illumination power density of artificial lighting, excluding heaters that emit light, must not exceed the following:

(1) In a Class 1 building, 5W/m2

(2) On a verandah or balcony attached to a Class 1 building, 4W/m2

(3) In a Class 10 building, 3W/m2

LOCATION	Size m2	Maximum wattage allowed
Class 1 building, 5W/m2	138.28	691.4
Verandah or Balcony attached to a Class 1 building, 4W/m2	h 77	21.32
Class 10 building, 3W/m2	35.81	107.43

Note: Artificial lighting around the perimeter of a building must:

(1) be controlled by a daylight sensor or

(2) have an average light source efficiency of not less than 40 Lumens/W

						r
PROP	OSED P	OWER USAGE FOR	ARTIFIC	AL LIGHTING		
LOCATION	NO.	TYPE	WATTS	PROPOSED WATTS	TOTAL WATTS	MAX WATTS
RESIDENCE	37	DOWNLIGHTS	10	370		
	0	BATTEN HOLDERS	28	0	ĺ	
	0	PENDANT LIGHTS	10	0	ĺ	
	0	EXHAUST FAN, HEAT & LIGHT UNIT	13	0		
					370	691.4
PORCH/VER Andah	1	DOWNLIGHTS	10	10		
	0	BATTEN HOLDERS	28	0	ĺ	
					10	21.32
GARAGE	0	DOWNLIGHTS	10	0		
	0	BATTEN HOLDERS	28	0		
	2	FLOURESCENT TUBES	18	36		
					36	107.43
					416	820

Is this electrical plan compliant?

Smoke Detectors to comply with AS3786 and interconnected to mains in accordance with BCA-Part 3.7.5.

Exhaust Fan.

Exhaust fan flow rates as per the clause 3.8.7.3 of NCC 2019.

Bathroom or Sanitary compartment -25L/s Kitchen or Laundry -40L/s.

Exhaust fans to be ducted to outside air.

METRE BOX NOTE:

Metre box to be installed at a nominal height of 1100mm above FFL to the bottom of the metre box.

Note:

Heating and cooling points are indicative only. Subject to site conditions and manufacturers specs and recommendations.

I/We acknowledge that these plans are a true and accurate reflection of our requirements and agree that these drawings, are the drawings referred to in our Building Contract, between Everest Homes and myself/ourselves. I/We are fully aware that a Variation fee will occur if any further changes are made on these plans.

(Signed).

(Signed).

Date: Amendment: Date: Issue: Amendment: ISSUE FOR CONSTRUCTION

AMENDED AS REQUESTED BY THE BUILDING SURVEYOR THIS DOCUMENT IS THE SUBJECT OF BUILDING PERMIT NUMBER: CBS-U 66127/49434

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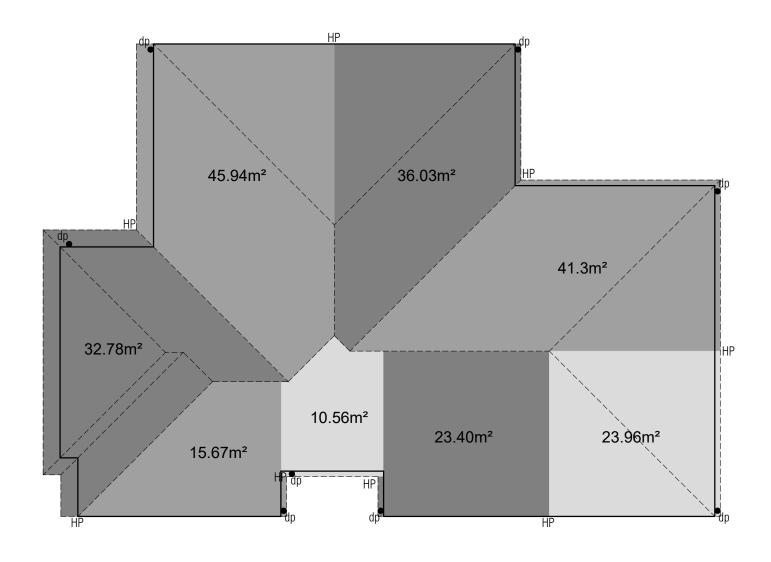
building design & drafting service interior design DOREEN PADULA DP-AD 45173

waters edge BUSINESS CENTRE PO Box 3379 Caroline Springs 3023 P: 9217 6405 F: 9217 6444 Scale: 1:100 Date: August 2022 Job.No: 3069

Drawing Title:

electrical layout





ROOF DRAINAGE CALCULATION IN ACCORDANCE WITH AS3500.3 DWELLING & ATTACHED GARAGE

Roof Area: 189.77 sq.m @ 22.5° Roof Pitch

Roof Catchment Area: 189.77 X 1.21 = 229.63sq.m

Proposed guttering has a cross-sectional area of 0.70L/s/m and will be installed with a slope of 1 in 500.

Minimum No. of downpipes = Roof catchment area divided by allowable maximum catchment per downpipe.

229.63 / 47 = 4.88.

5 No. of downpipes required.

Minimum downpipe size is 100 x 50 or 90mm.

Quad 115 Hi-front XL Slotted gutter.

acknowledge that these plans are a true and accurate reflection of our requirements and agree that these drawings, are the drawings referred

to in our Building Contract, between Everest Homes and myself/ourselves. I/We are fully aware that a Variation fee will occur if any further changes are made on these plans.

(Signed)..

(Signed)..

Date: Amendment: Date: Amendment: Issue: Issue: ISSUE FOR CONSTRUCTION

AMENDED AS REQUESTED BY THE BUILDING SURVEYOR THIS DOCUMENT IS THE SUBJECT OF BUILDING PERMIT NUMBER: CBS-U 66127/49434

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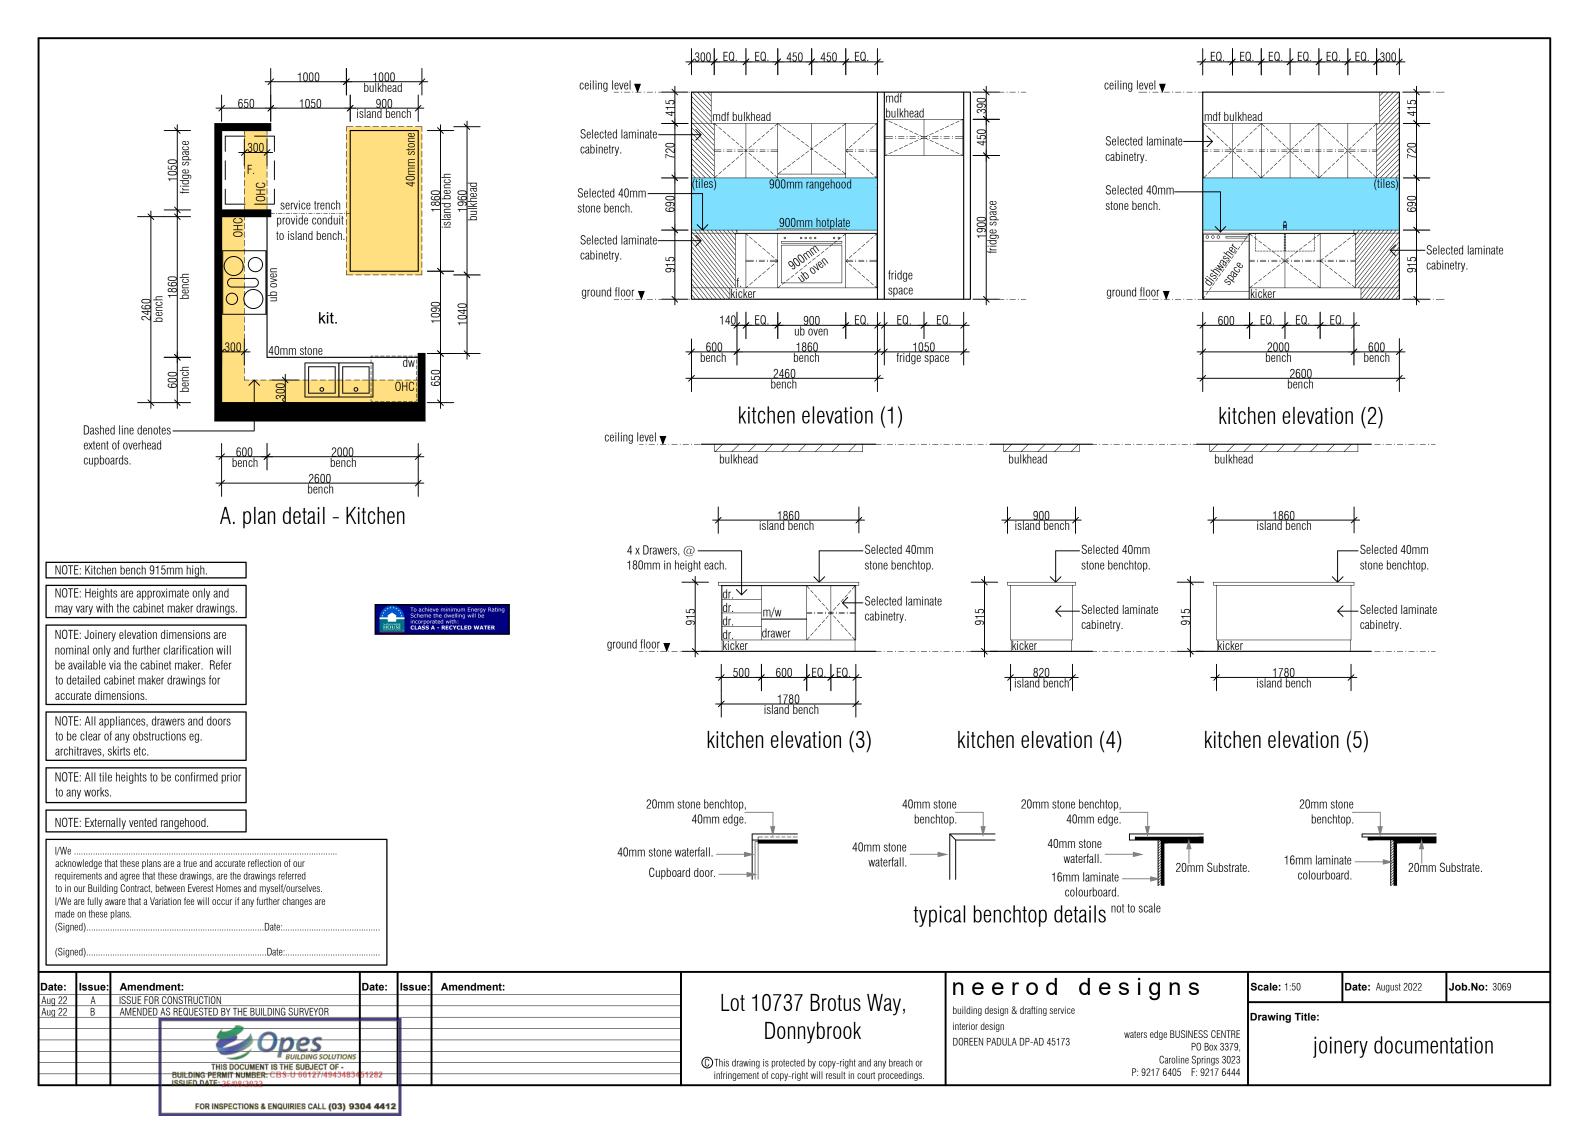
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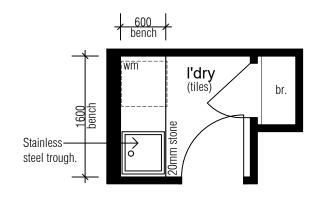
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waters edge BUSINESS CENTRE PO Box 3379, Caroline Springs 3023 P: 9217 6405 F: 9217 6444 Scale: 1:100 Date: August 2022 **Job.No:** 3069

Drawing Title:


roof catchment drainage plan






B. plan detail - Laundry



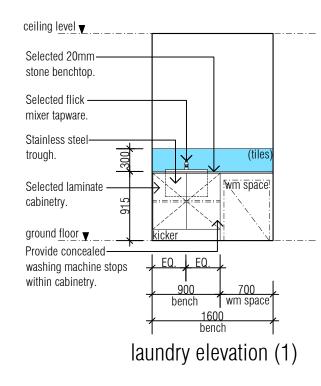


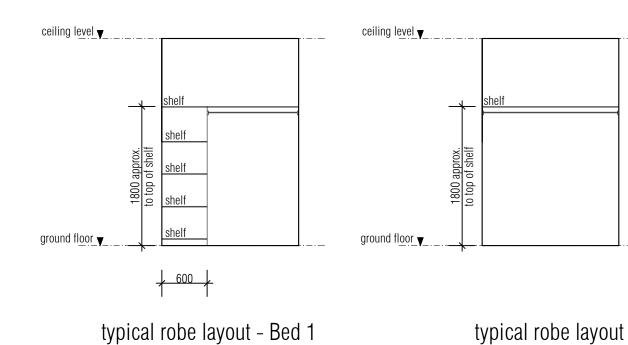

study nook

Selected laminate
benchtop.

C. plan detail - Study Nook

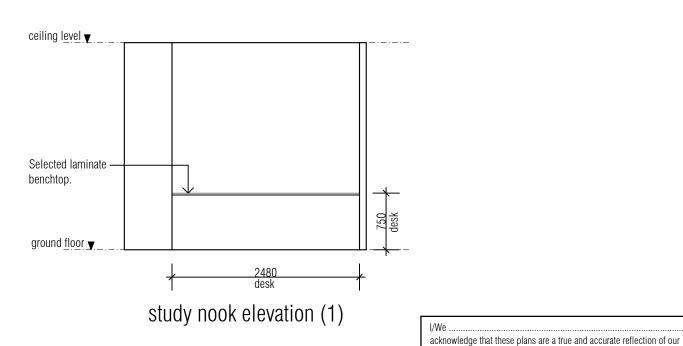

may vary with the cabinet maker drawings.

NOTE: Joinery elevation dimensions are nominal only and further clarification will be available via the cabinet maker. Refer.

NOTE: Heights are approximate only and

NOTE: Laundry bench 915mm high.

nominal only and further clarification will be available via the cabinet maker. Refer to detailed cabinet maker drawings for accurate dimensions.

NOTE: All tiles heights to be confirmed prior to works.

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made on these plans.

(Signed)...

Scale: 1:50 Date: August 2022 Job.No: 3069

Drawing Title:


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requirements and agree that these drawings, are the drawings referred

to in our Building Contract, between Everest Homes and myself/ourselves.

I/We are fully aware that a Variation fee will occur if any further changes are



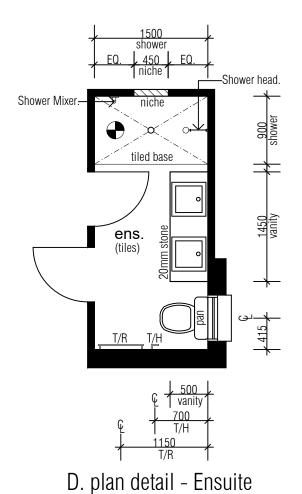



NOTE: Heights are approximate only and may vary with the cabinet maker drawings.

NOTE: Joinery elevation dimensions are nominal only and further clarification will be available via the cabinet maker. Refer to detailed cabinet maker drawings for accurate dimensions.


NOTE: All tiles heights to be confirmed prior to works.

NOTE: Vanity unit heights 800-900mm high.

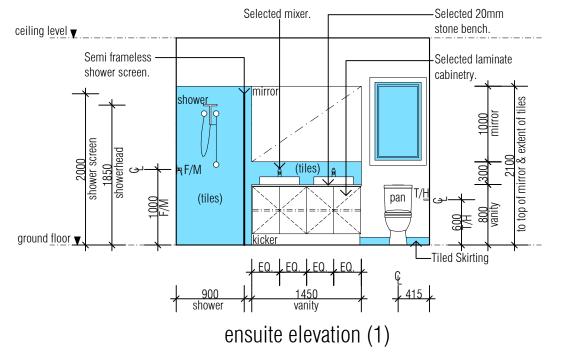


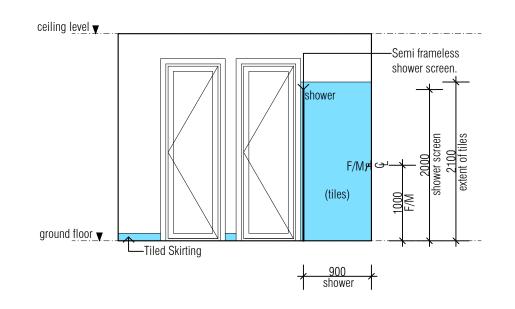

ensuite elevation (3)

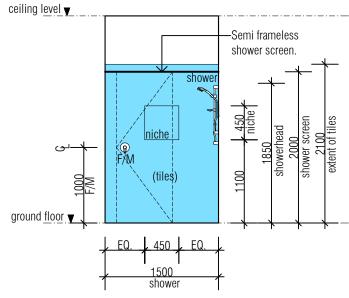

ensuite elevation (2)

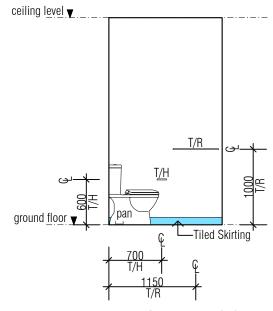

ensuite elevation (4)

I/Weacknowledge that these plans are a true and accurate reflection of our requirements and agree that these drawings, are the drawings referred to in our Building Contract, between Everest Homes and myself/ourselves. I/We are fully aware that a Variation fee will occur if any further changes are	
made on these plans. (Signed)Date:Date:	
(Signed)Date:	

	Issue:	Amendment:			Issue:	Amendment:
Aug 22	Α	ISSUE FOR CONSTRUCTION				
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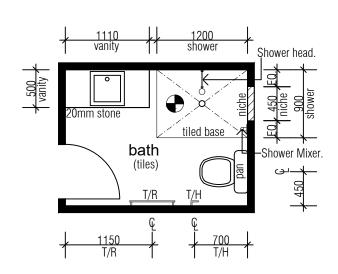
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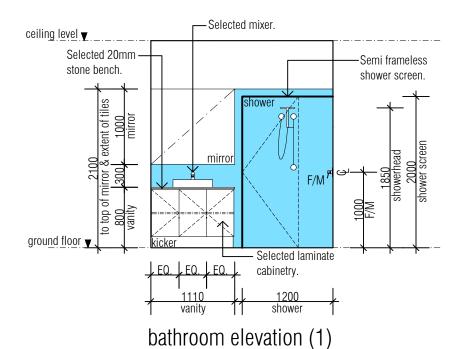
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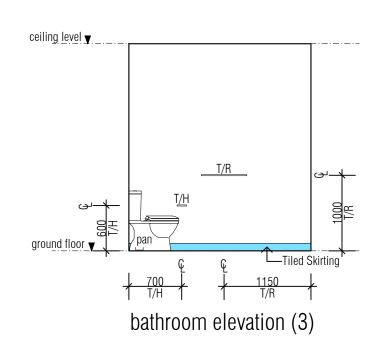
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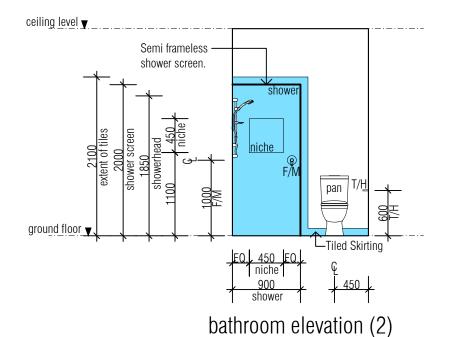





E. plan detail - Bathroom







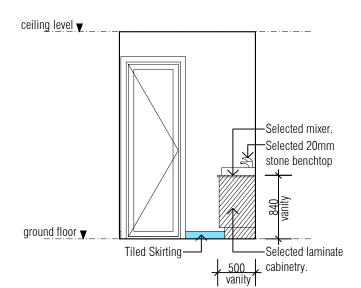

bathroom elevation (4)

requirements and agree that these to in our Building Contract, betwe	a true and accurate reflection of our e drawings, are the drawings referred sen Everest Homes and myself/ourselves. on fee will occur if any further changes are
l '	Date:
(Signed)	Date:

NOTE: Vanity unit heights 800-900mm high.

NOTE: All tiles heights to be confirmed

accurate dimensions.

prior to works.

NOTE: Heights are approximate only and may vary with the cabinet maker drawings.

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Scale: 1:50 Date: August 2022 Job.No: 3069 Drawing Title:

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